




4 PASSENGER ELEVATOR RAIL SCHEDULE
SCALE: 1/2" = 1'-0"

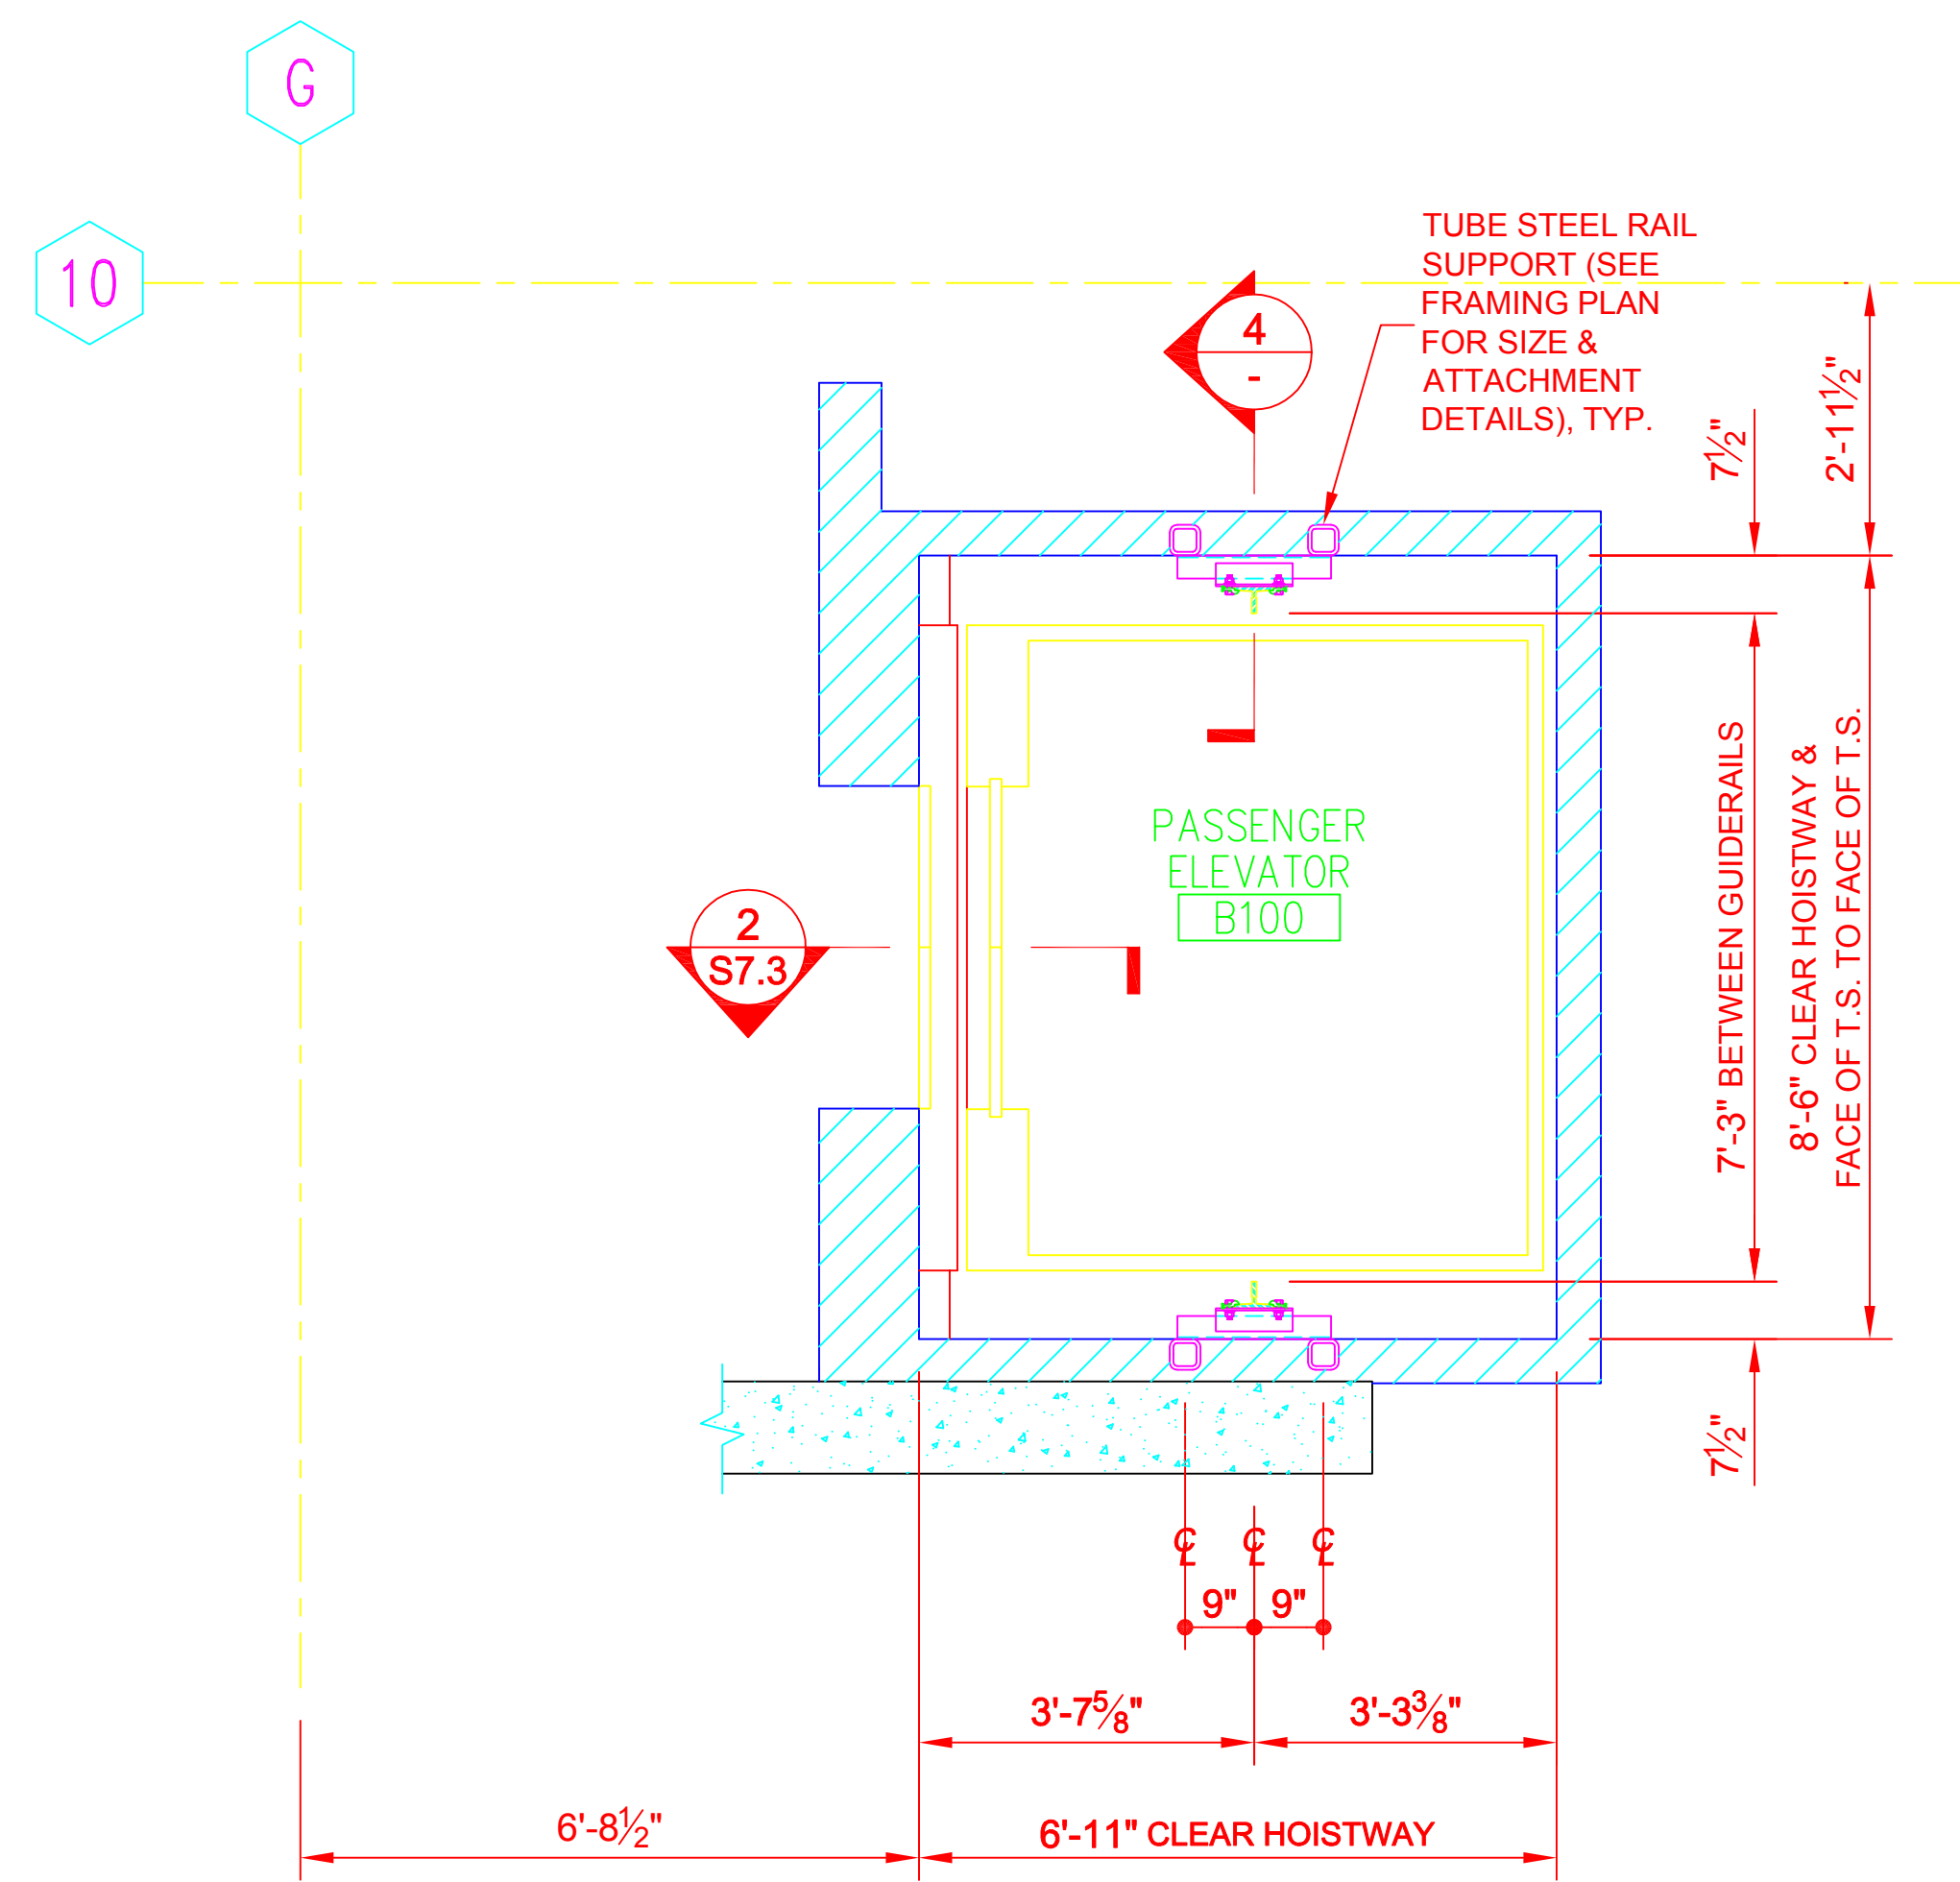

3 PASSENGER ELEVATOR LEVEL 2 PLAN
SCALE: 1/2" = 1'-0"

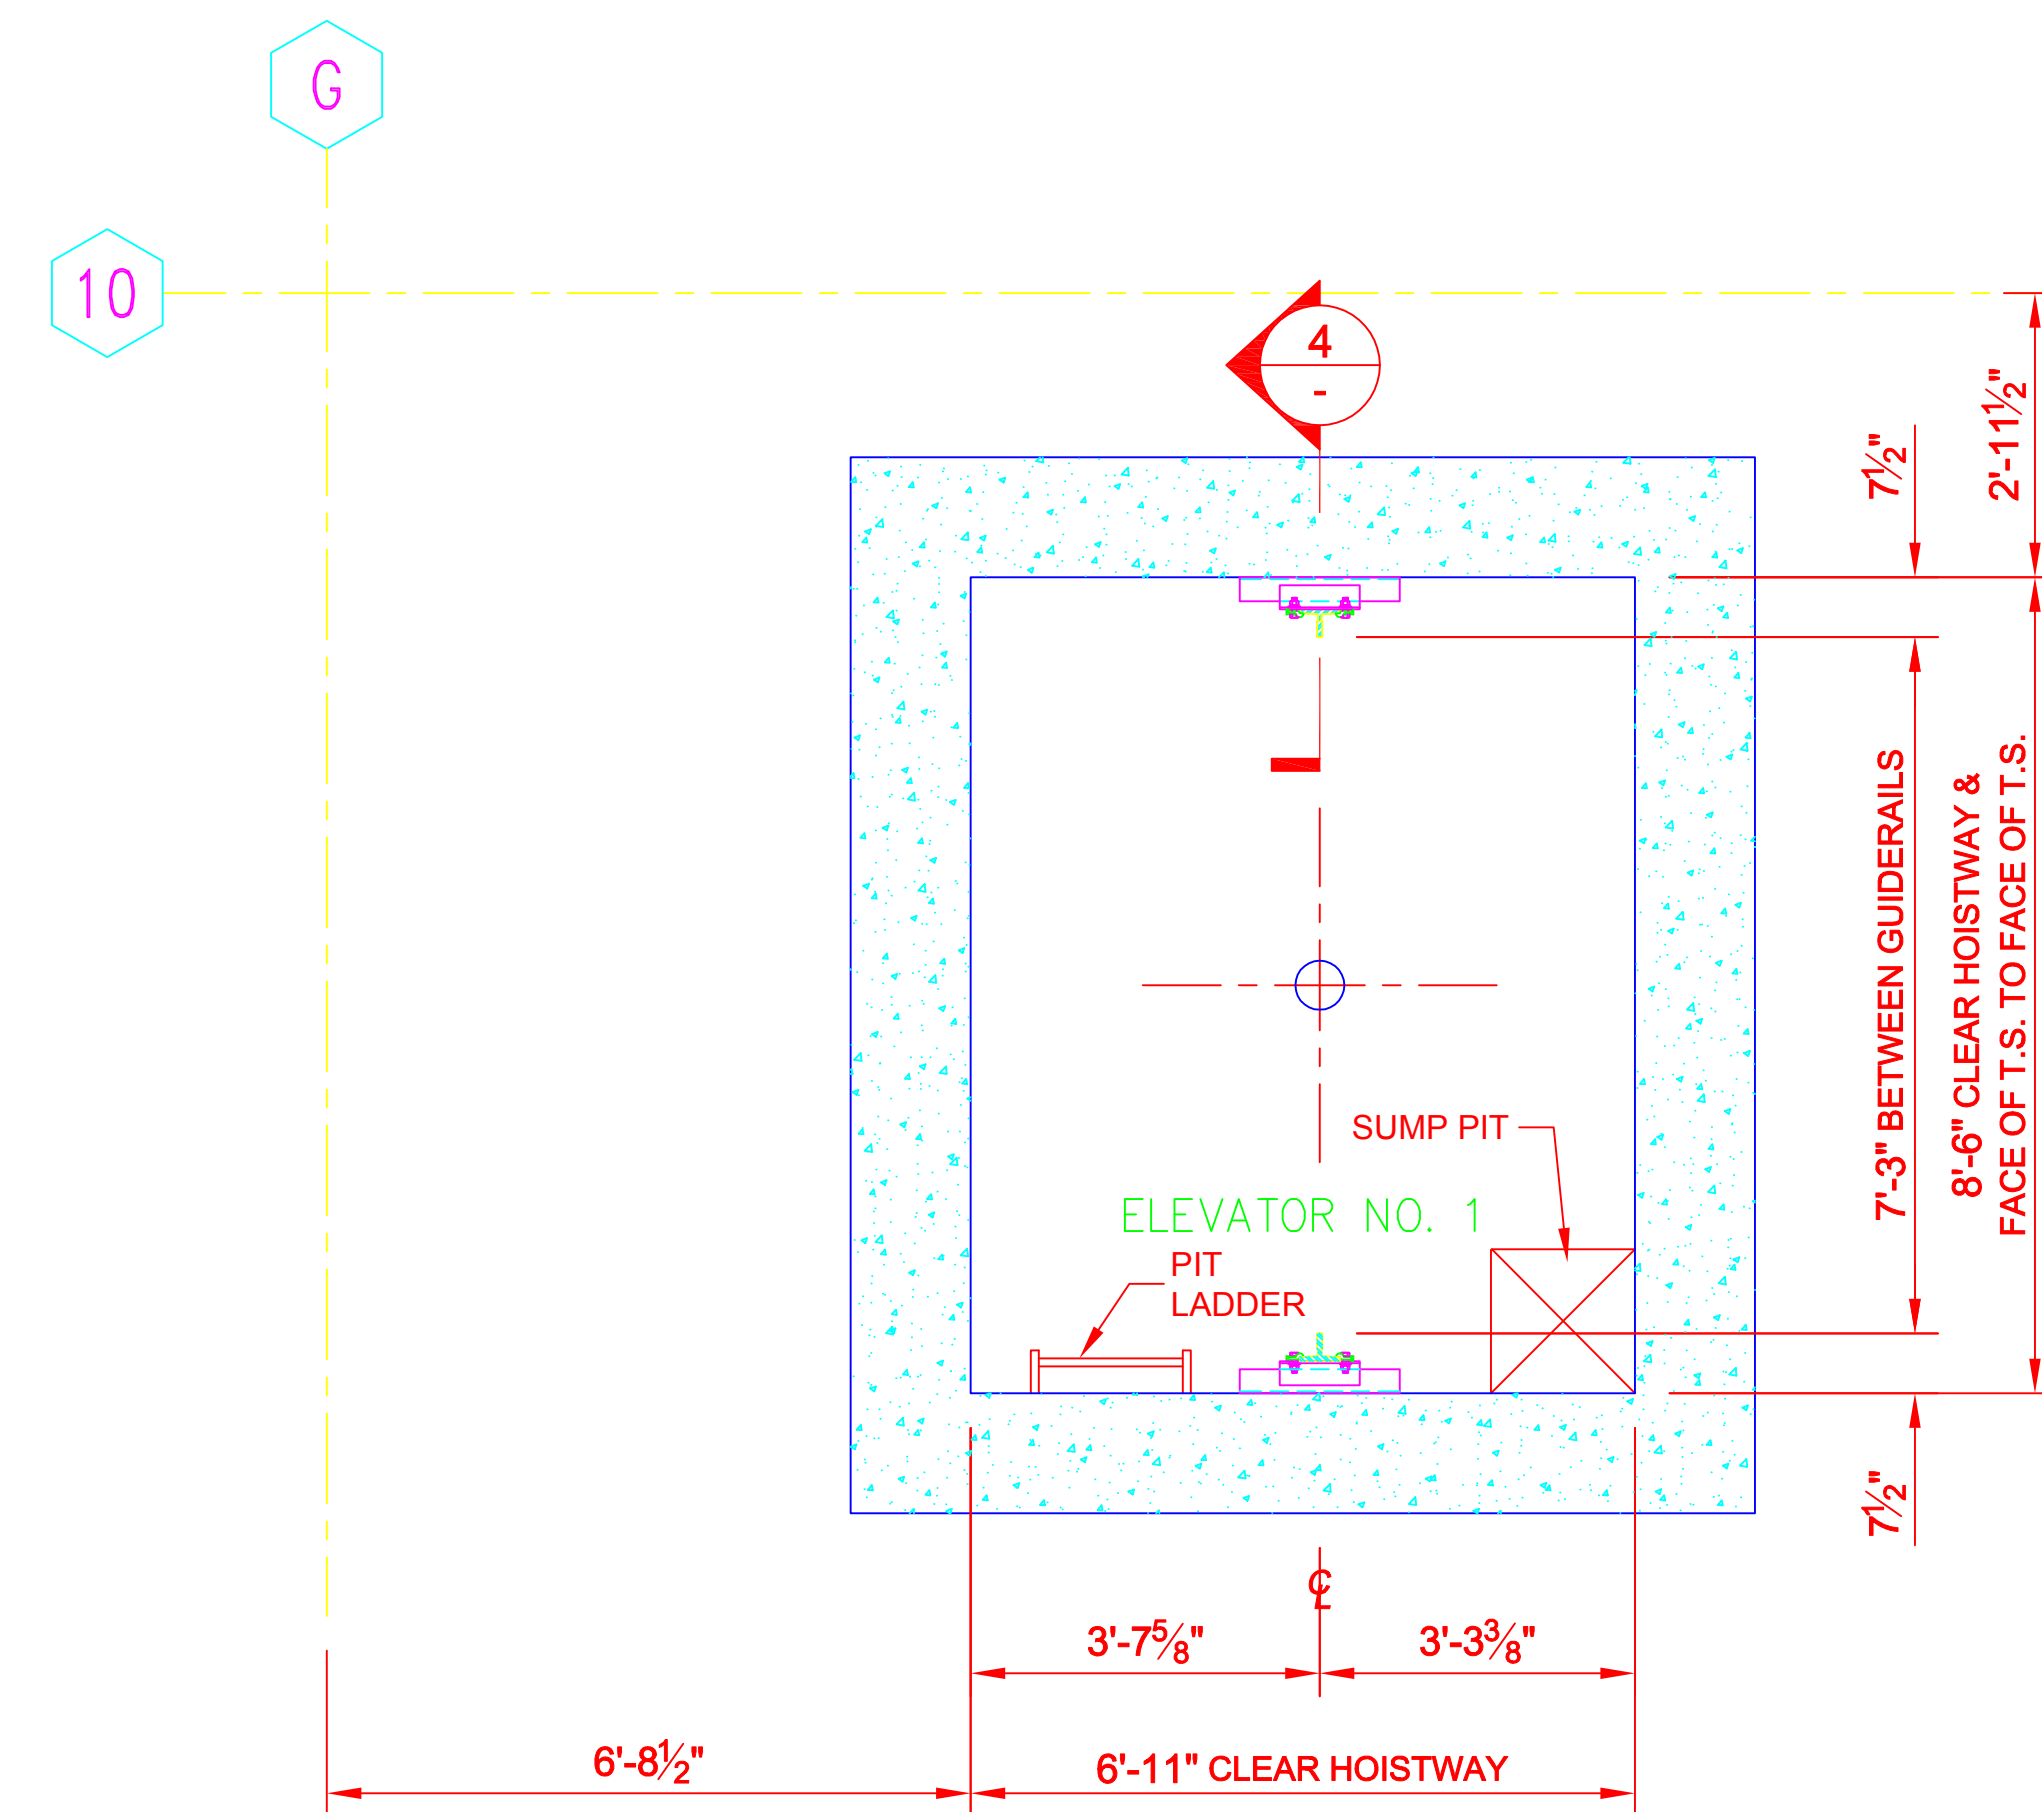

1 PASSENGER ELEVATOR PIT PLAN
SCALE: 1/2" = 1'-0"

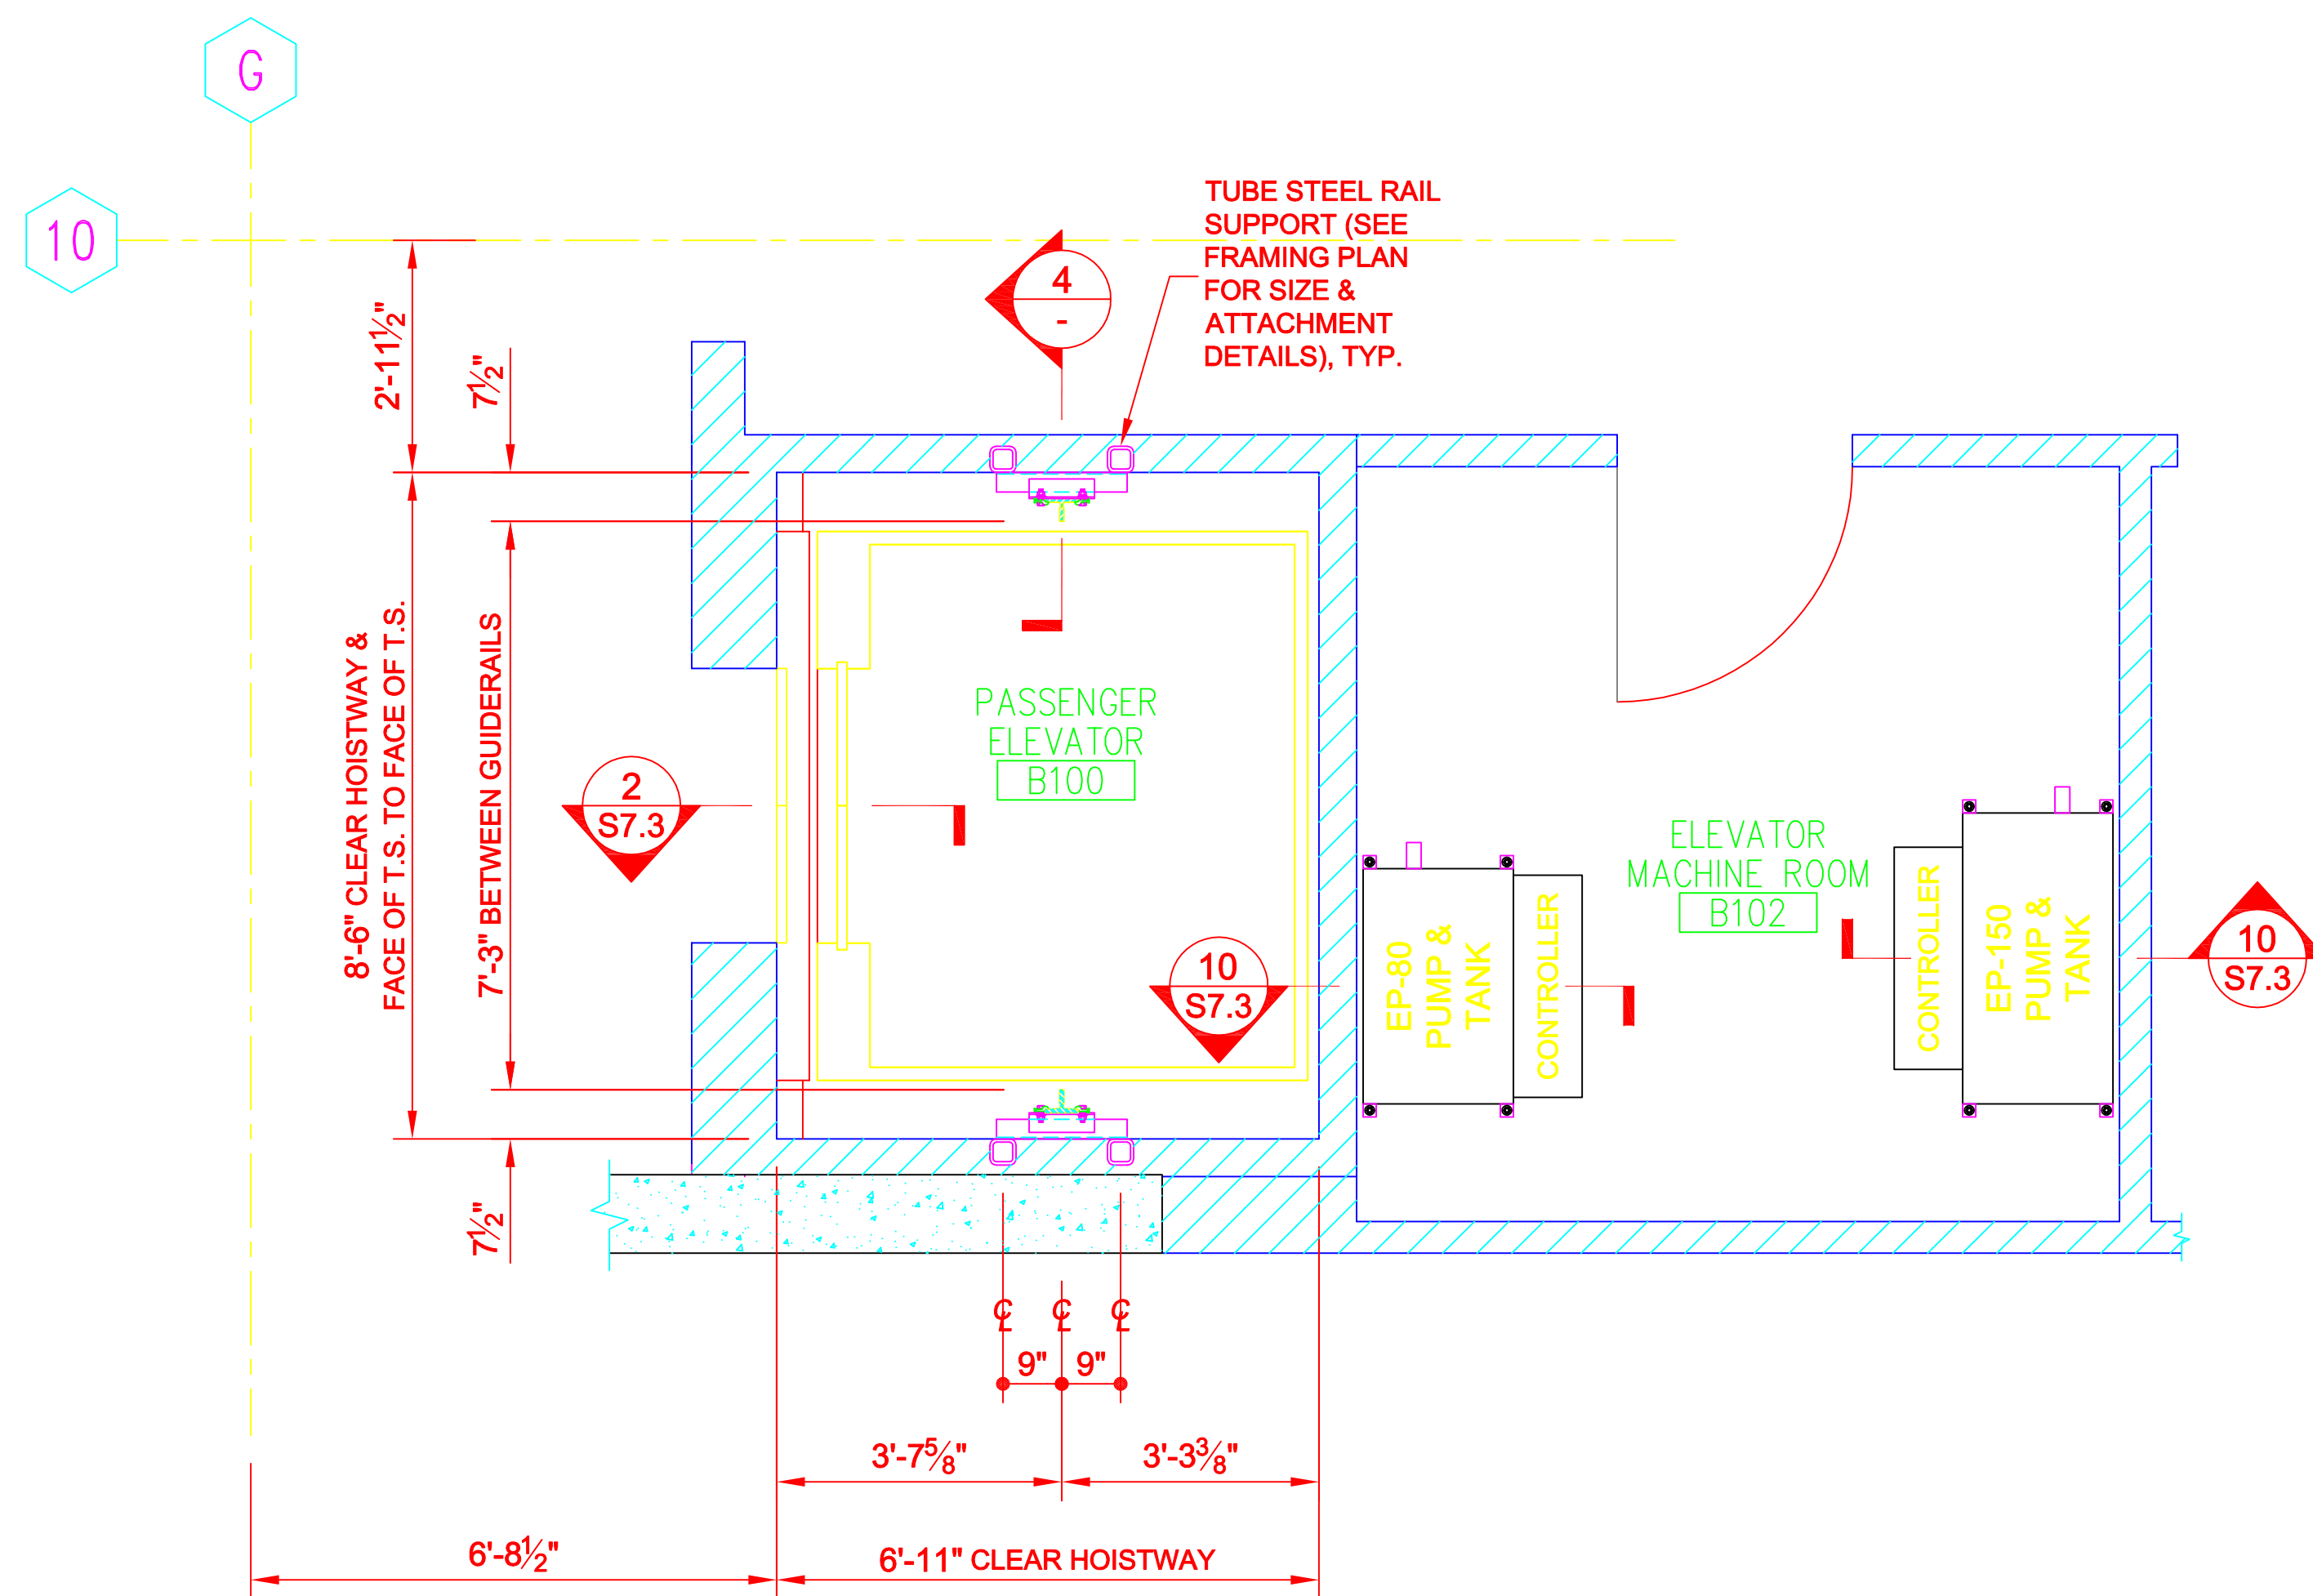

2 PASSENGER ELEVATOR LEVEL 1 & MACHINE ROOM PLAN
SCALE: 1/2" = 1'-0"

ELEVATOR INFORMATION (ALL WEIGHTS AND LOADS ARE IN POUNDS)			
ELEVATOR NO.	1	2	
ELEVATOR NAME	PASSENGER	FREIGHT	
CAR CAPACITY	3500	5000	
CAR WEIGHT (MAX.)	3000	4000	
PLUNGER WEIGHT	300	600	
R1 (SEISMIC)	1542	2150	
R2 (SEISMIC)	771	1075	

ANSHEN+ALLEN

Architect
Anshen + Allen
901 Market Street
San Francisco, CA 94103
(415) 882-9500

Elevator Structural Engineer
EDDINGTON ENGINEERING
1116 SINGINGWOOD RD.
SACRAMENTO, CA 95864
(916) 973-0113



Registration Stamp

Approval

No. Revision Date

Project

Science Center
at De Anza Campus

Foothill - De Anza Community College
Project No. 20043.00

90% Construction Documents

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Sheet Title

Passenger Elevator Plans
& Rail Schedules

Scale AS NOTED

Date November 19, 2001

Project No. 20043.00

Drawing No.

S7.1

Architect
Anshen + Allen
901 Market Street
San Francisco, CA 94103
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Elevator Structural Engineer
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SACRAMENTO, CA 95864
(916) 973-0113



Registration Stamp

Approval

No.	Revision	Date
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Project

Science Center
at De Anza Campus

Foothill - De Anza Community College
Project No. 20043.00

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Sheet Title

Freight Elevator Plans
& Rail Schedules

Scale	AS NOTED
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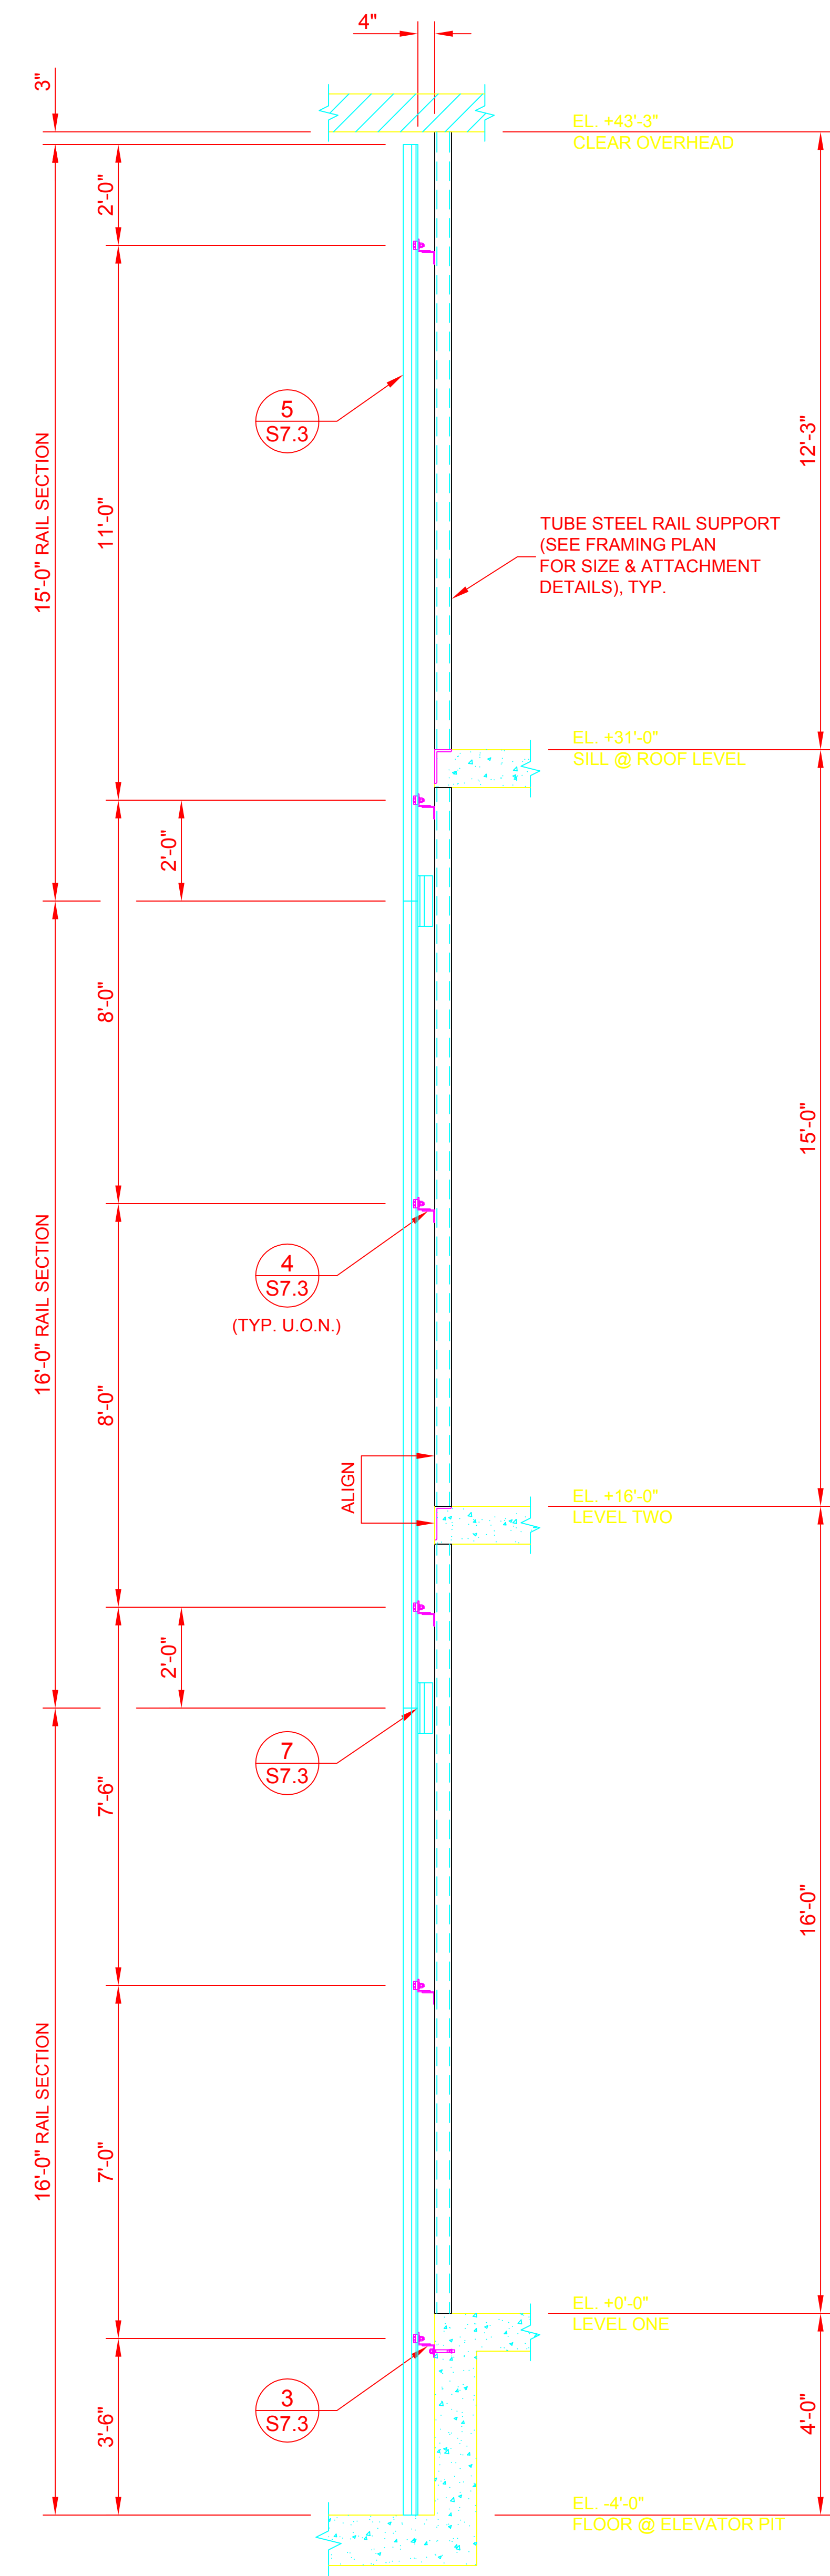
Date	November 19, 2001
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Project No.	20043.00
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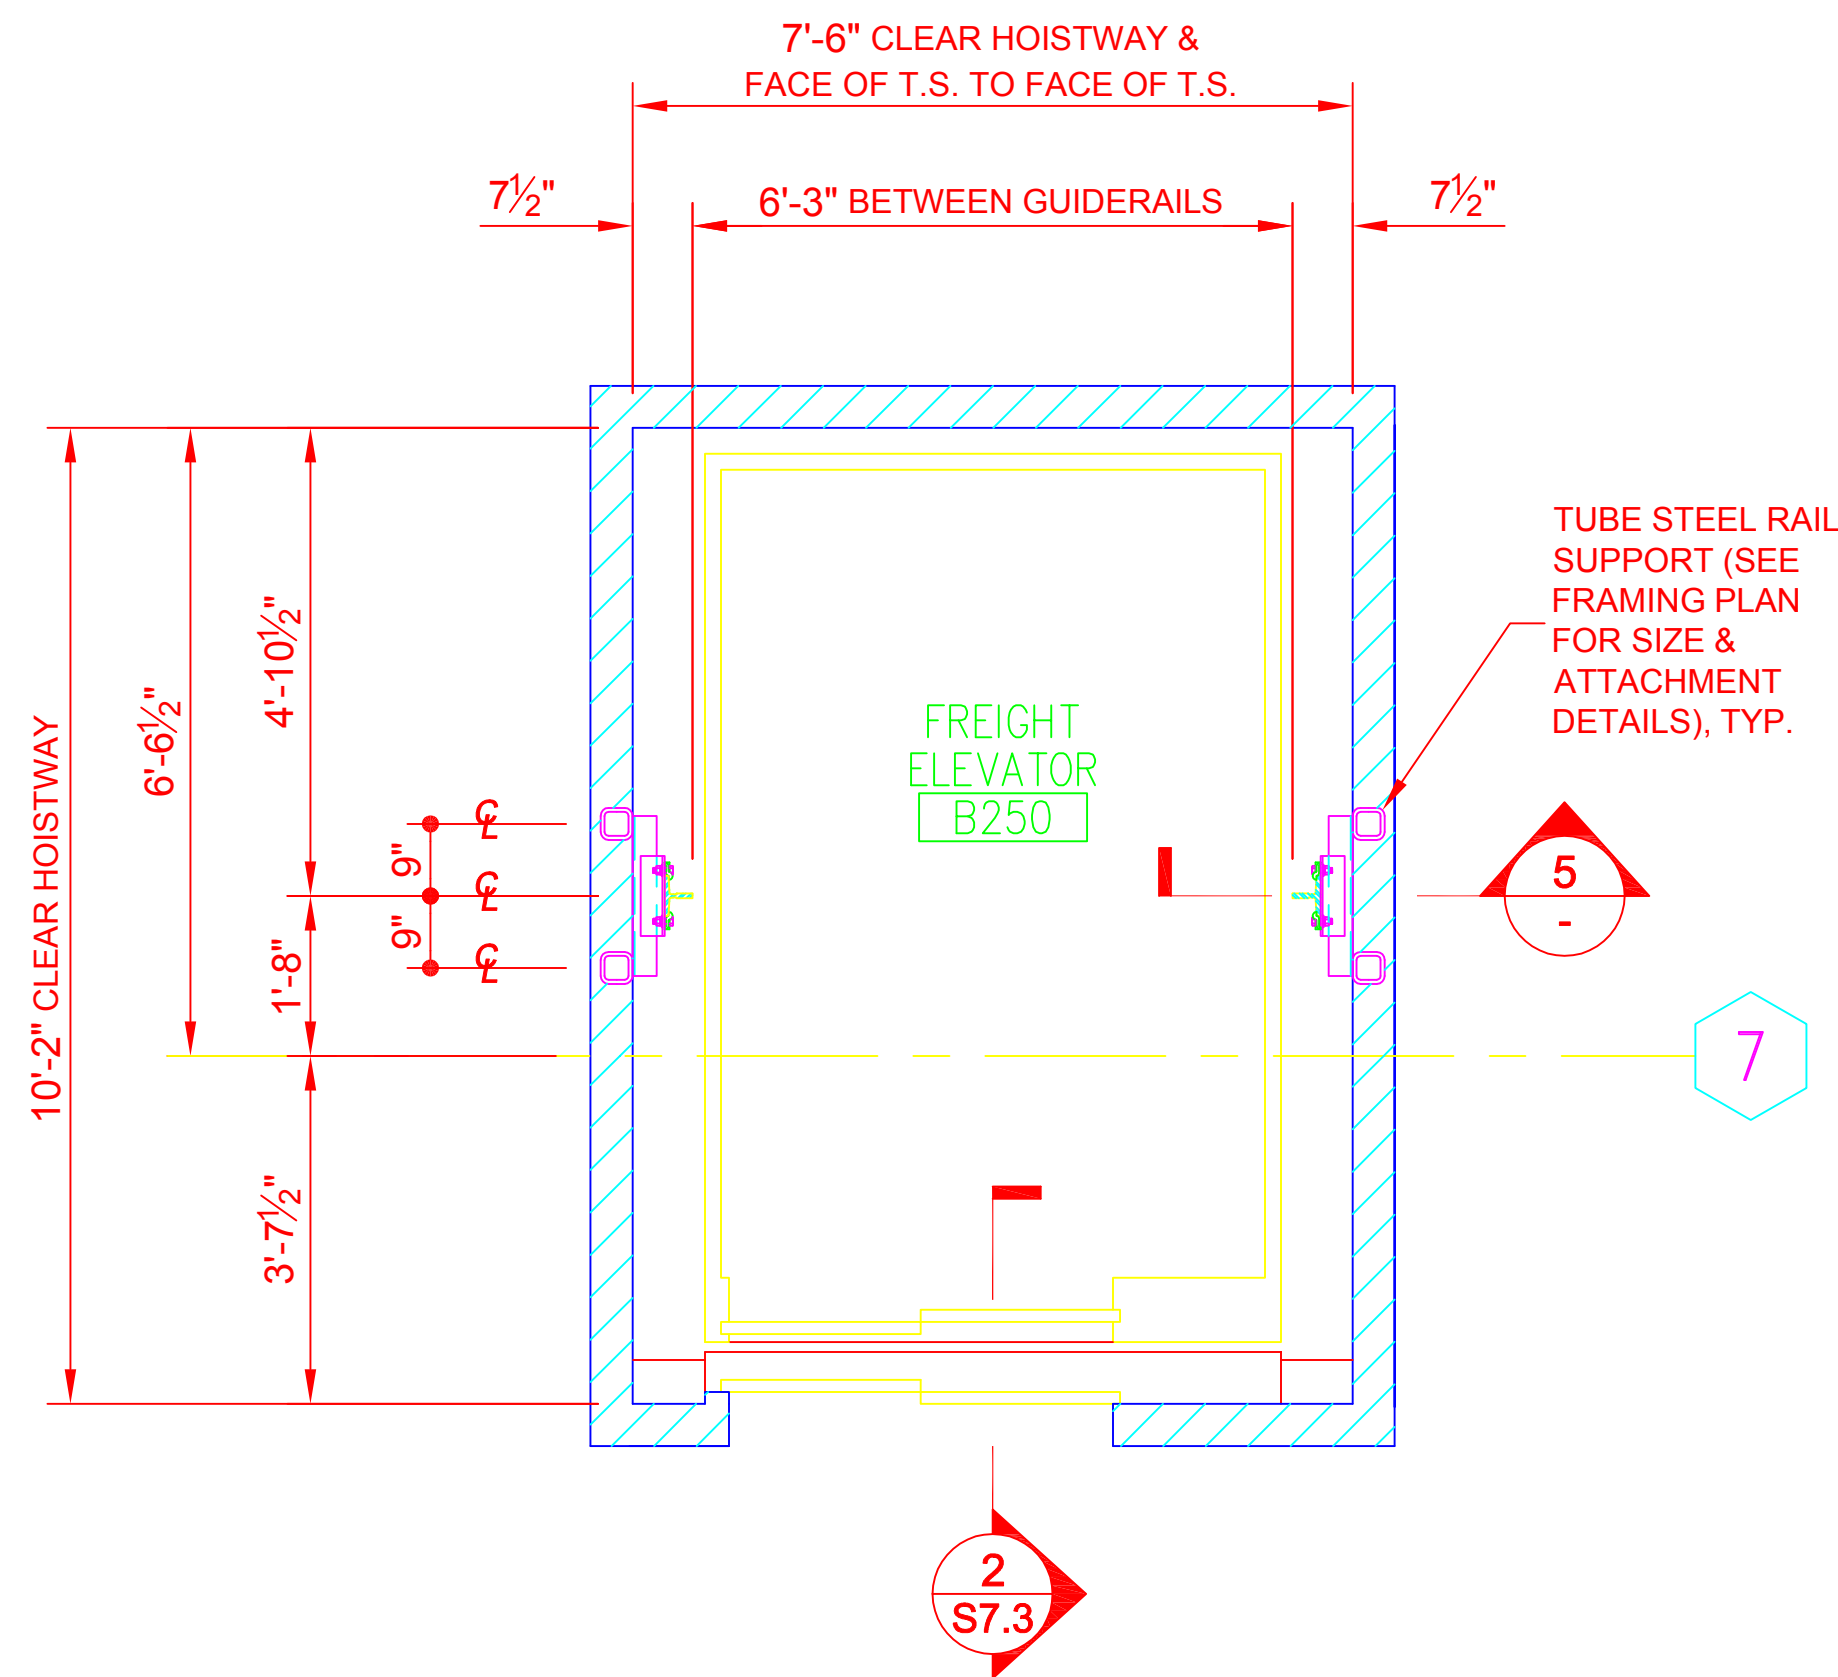
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S7.2


If this drawing is not 24"x36" it is a reduced print.




5 FREIGHT ELEVATOR RAIL SCHEDULE
SCALE: 1/2" = 1'-0"




3 FREIGHT ELEVATOR LEVEL 2 PLAN
SCALE: 1/2" = 1'-0"

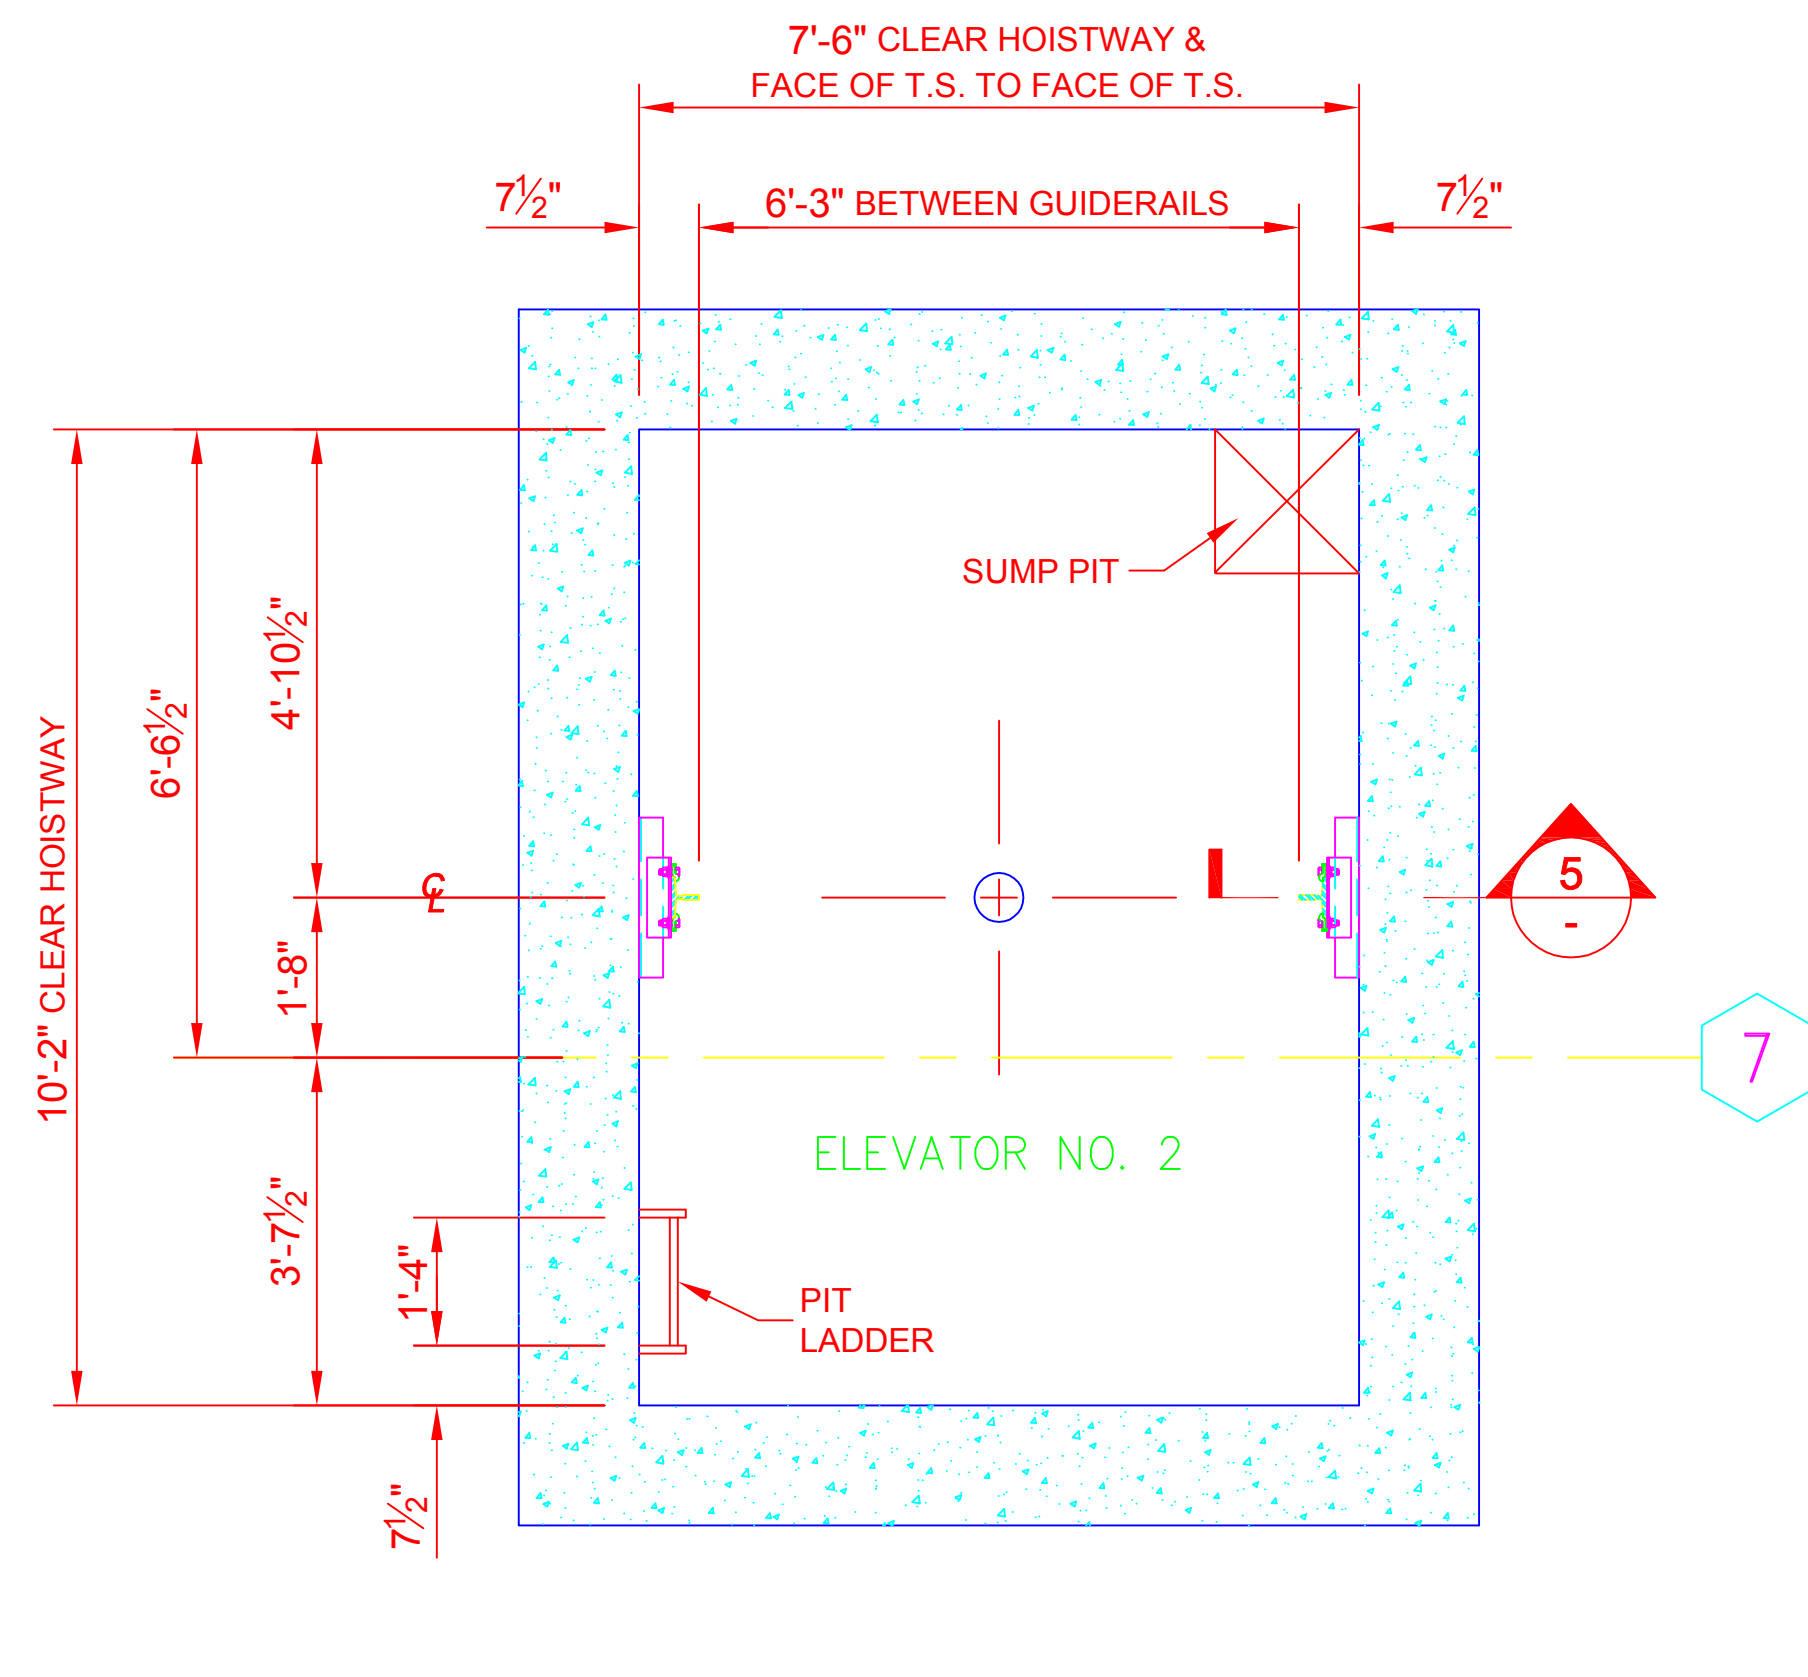

1 FREIGHT ELEVATOR PIT PLAN
SCALE: 1/2" = 1'-0"

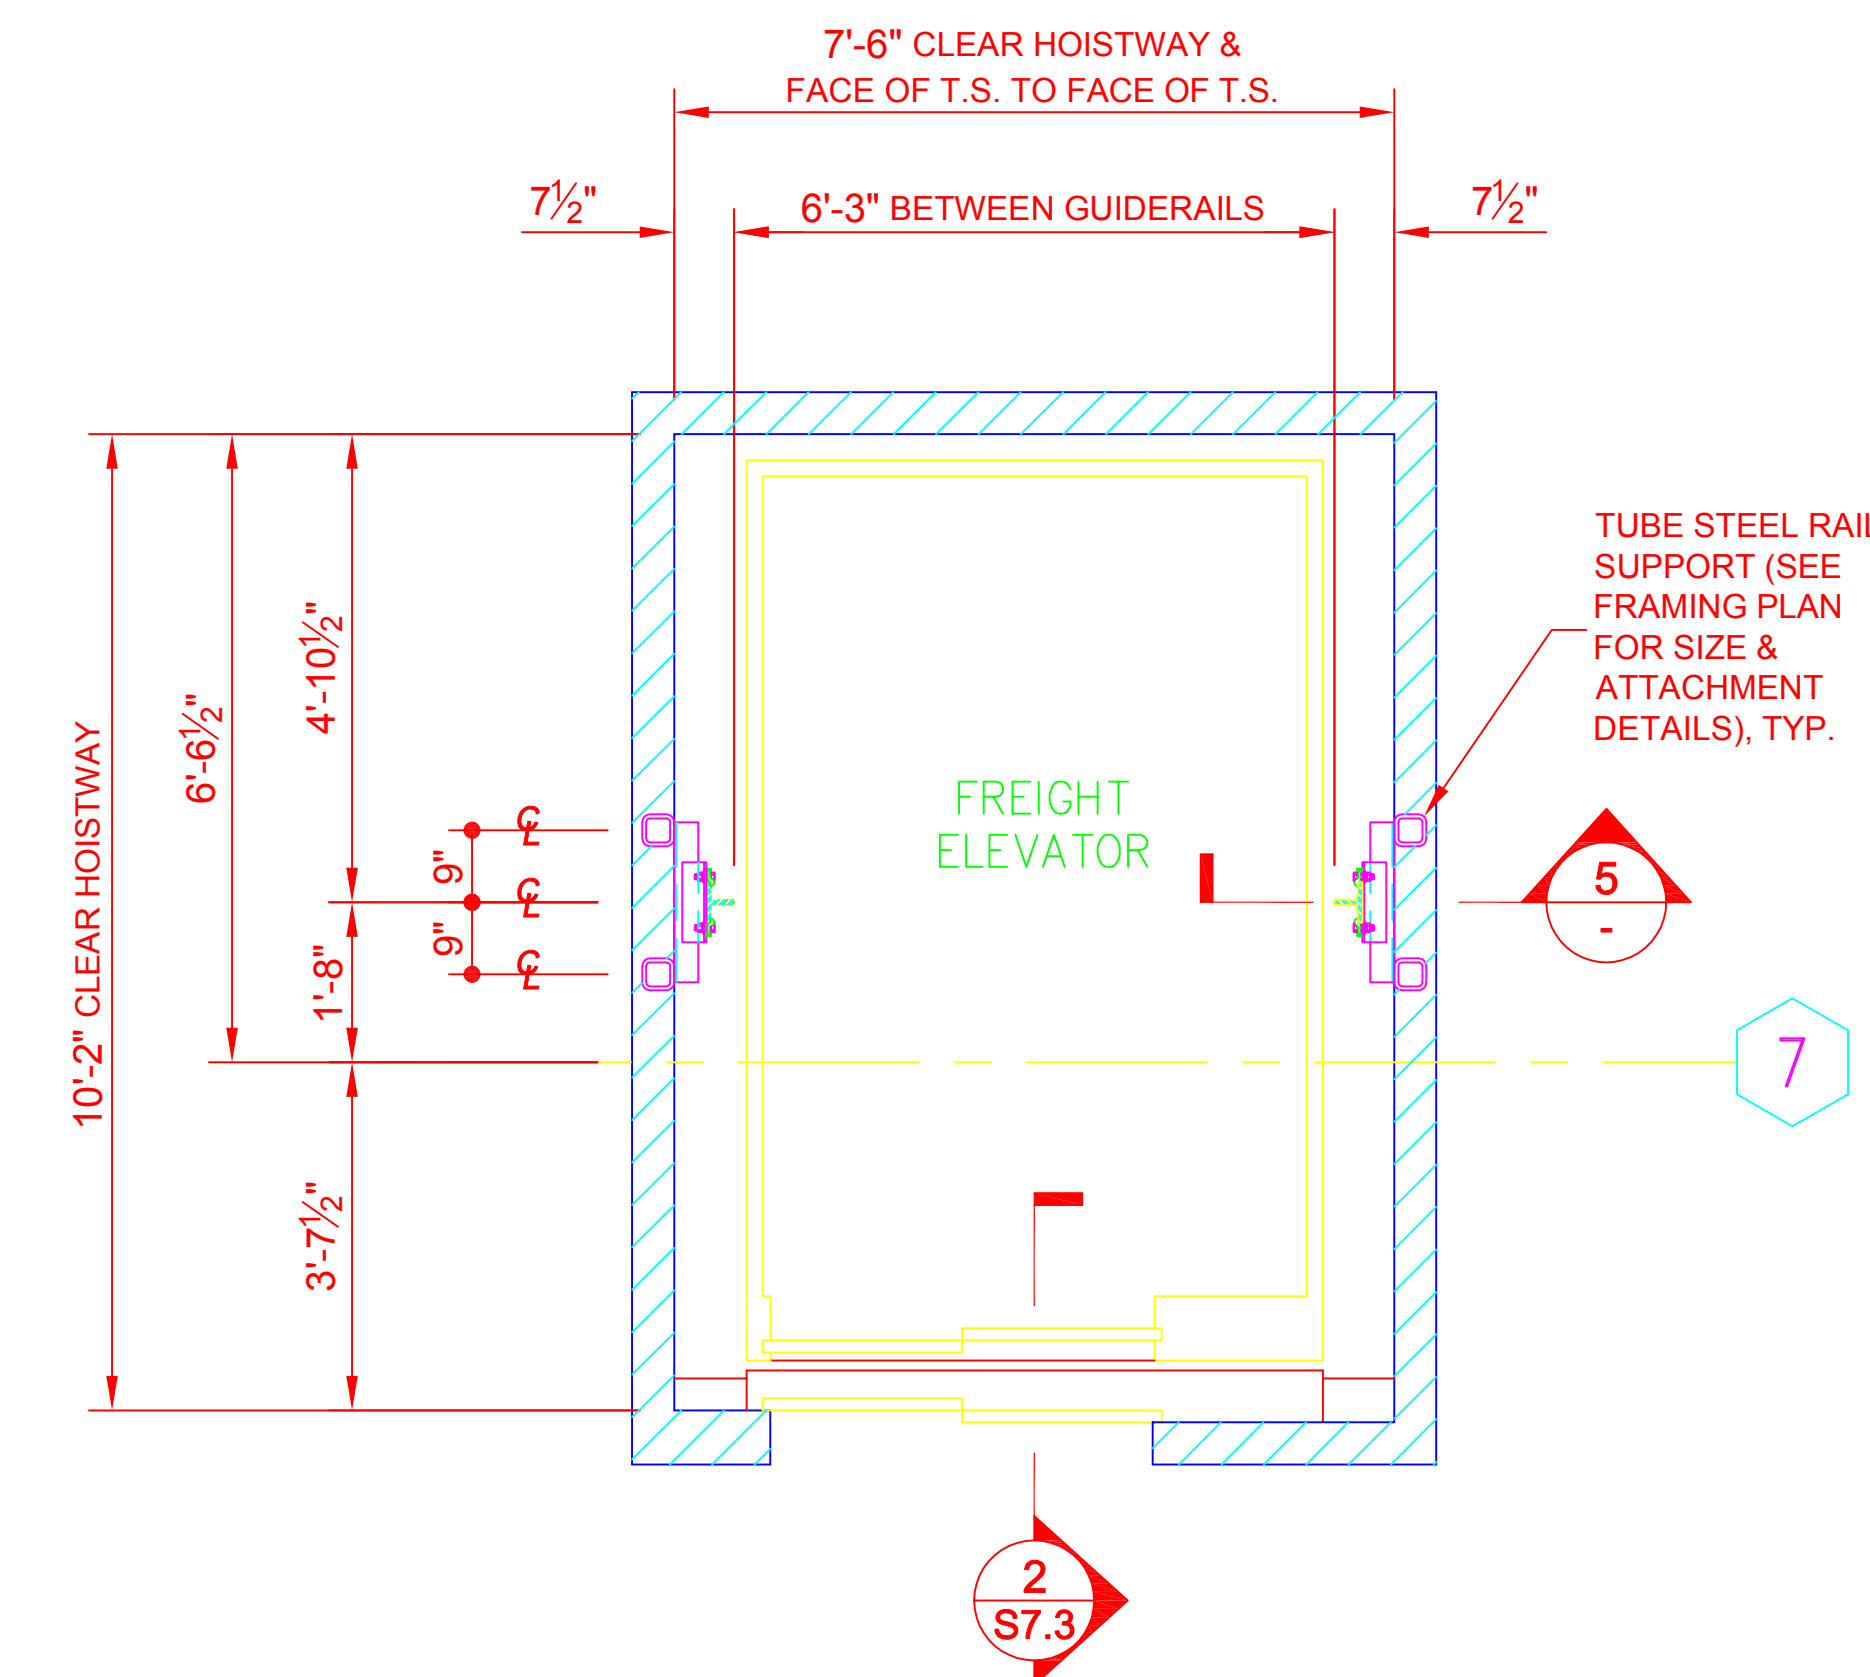

4 FREIGHT ELEVATOR ROOF PLAN
SCALE: 1/2" = 1'-0"

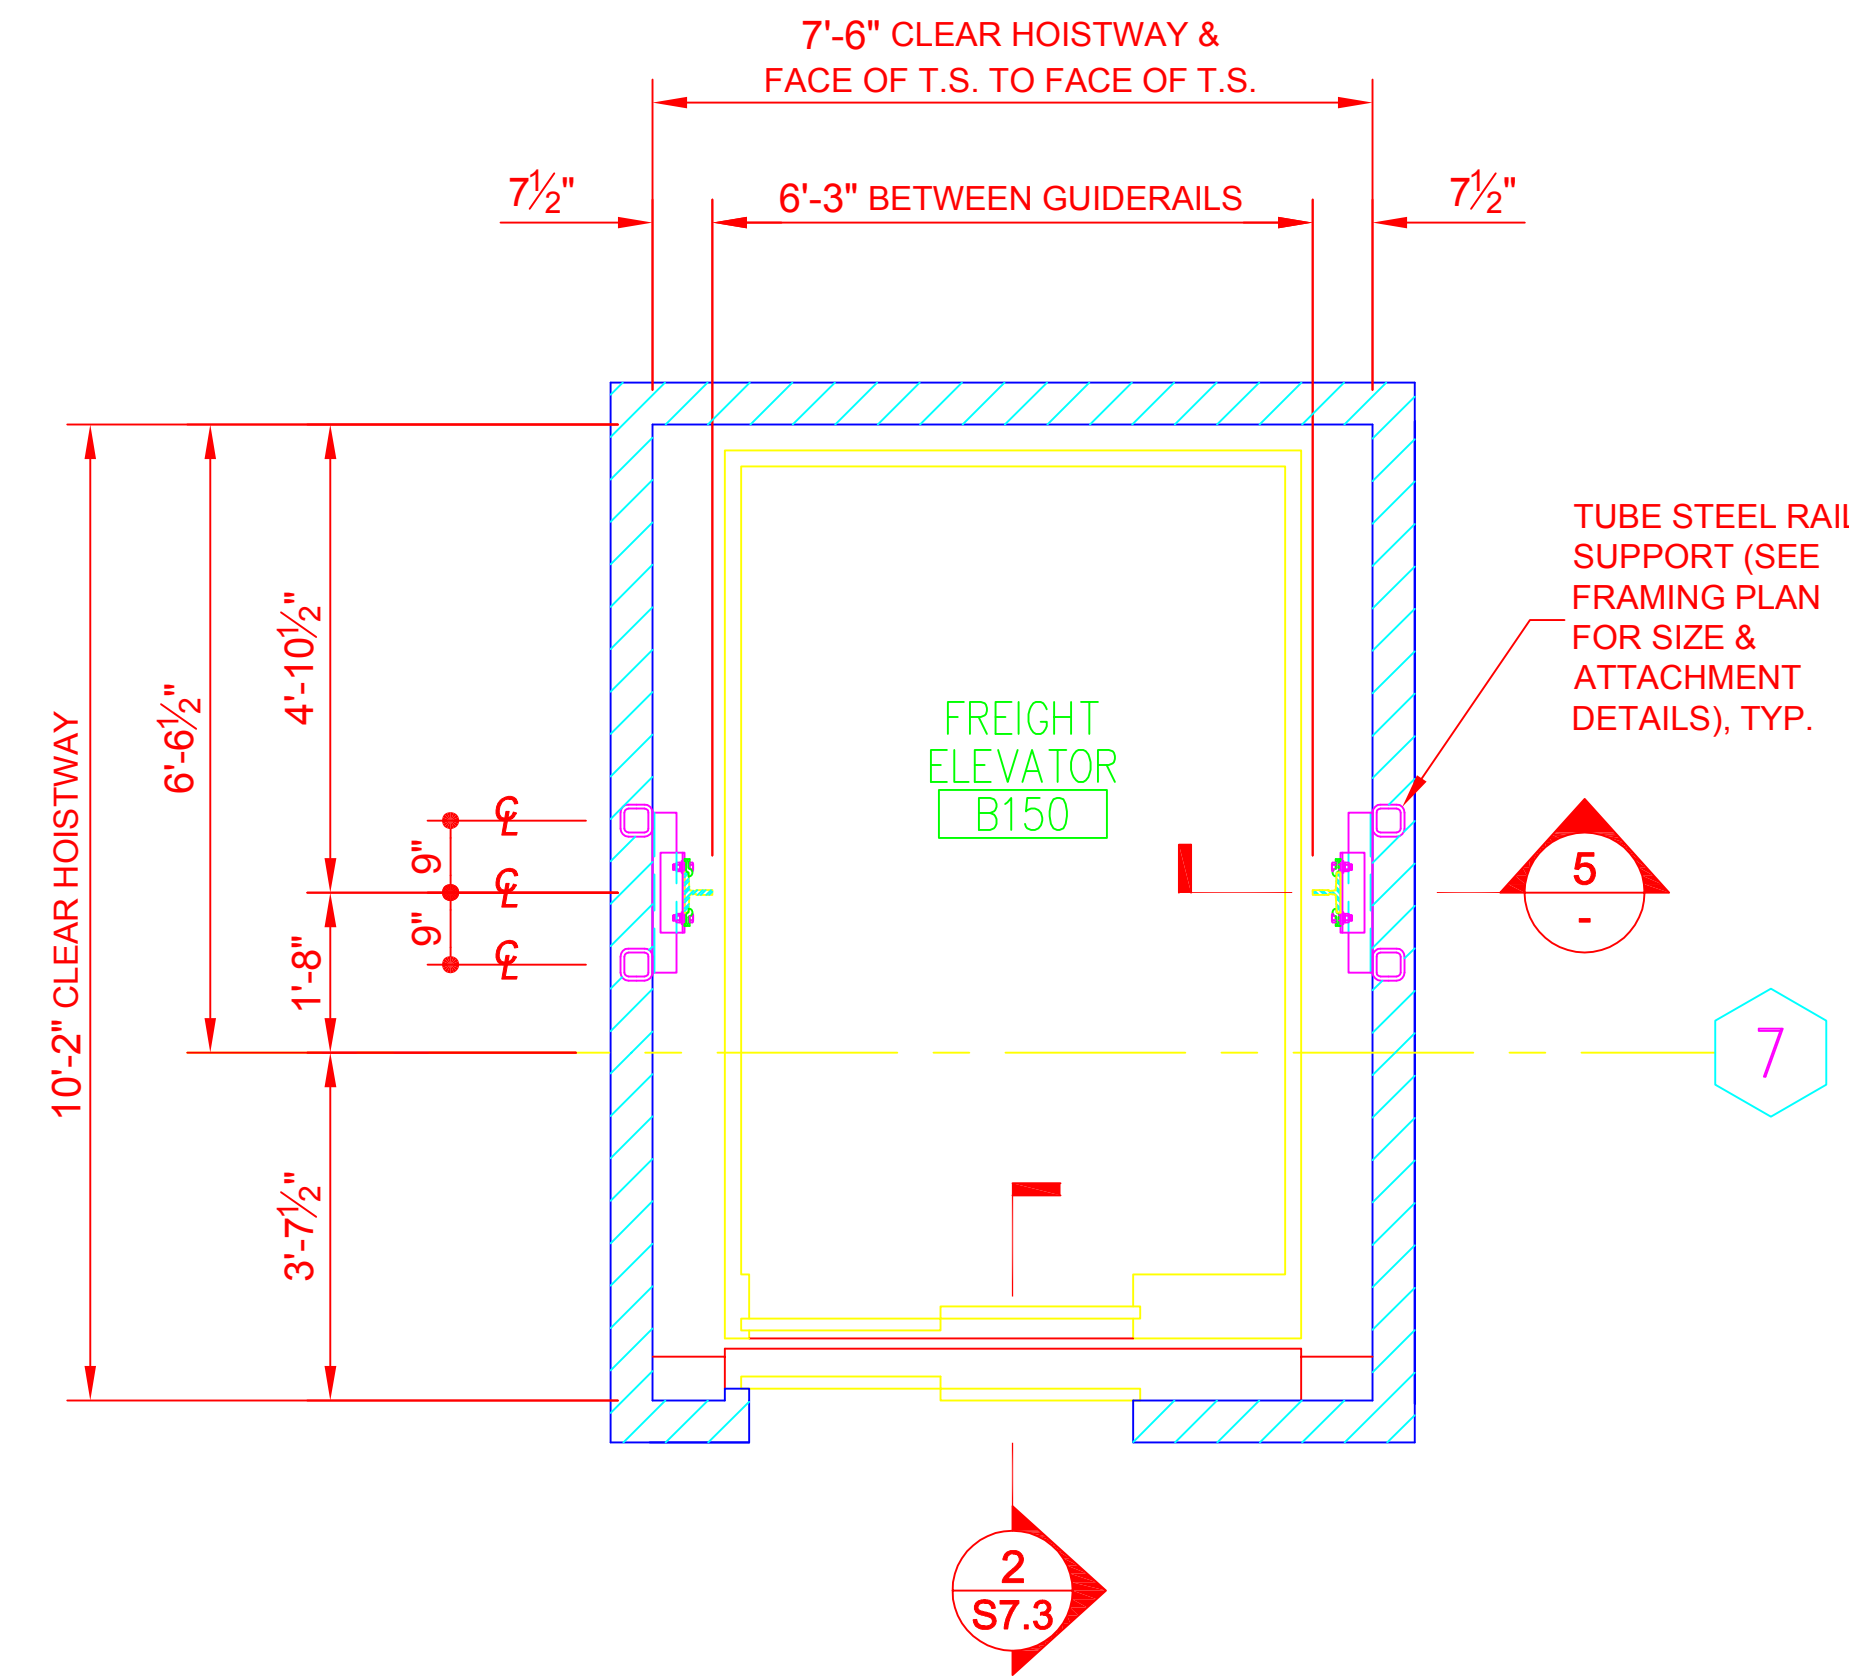


2 FREIGHT ELEVATOR LEVEL 1 PLAN
SCALE: 1/2" = 1'-0"

Approva

Sheet Title
Typical Details &
General Notes

Scale AS NOTED

S7.3

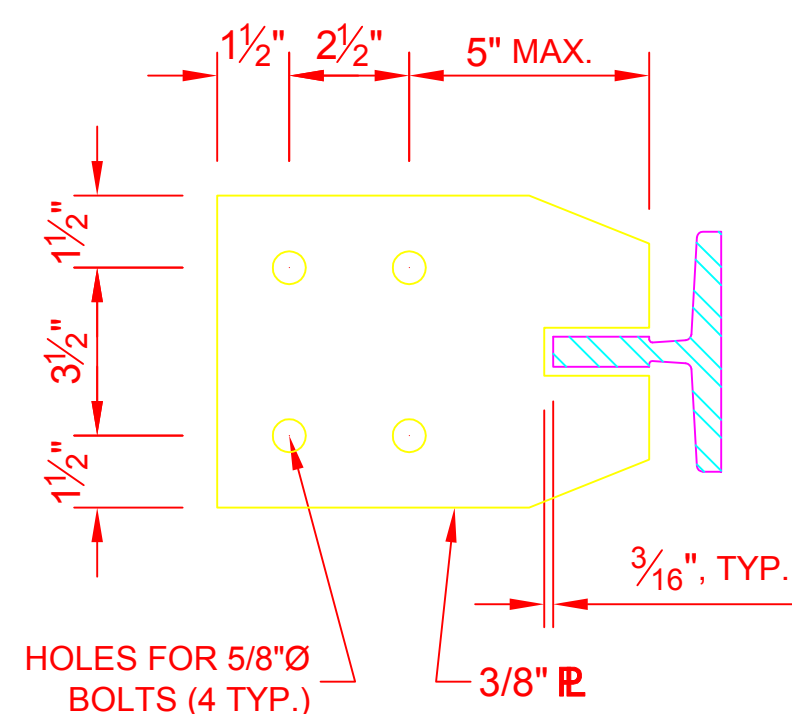

NOTE:
1. ALL DIMENSIONS ARE
MINIMUM (U.O.N.)

